




APPENDIX D DESIGN DRAWINGS

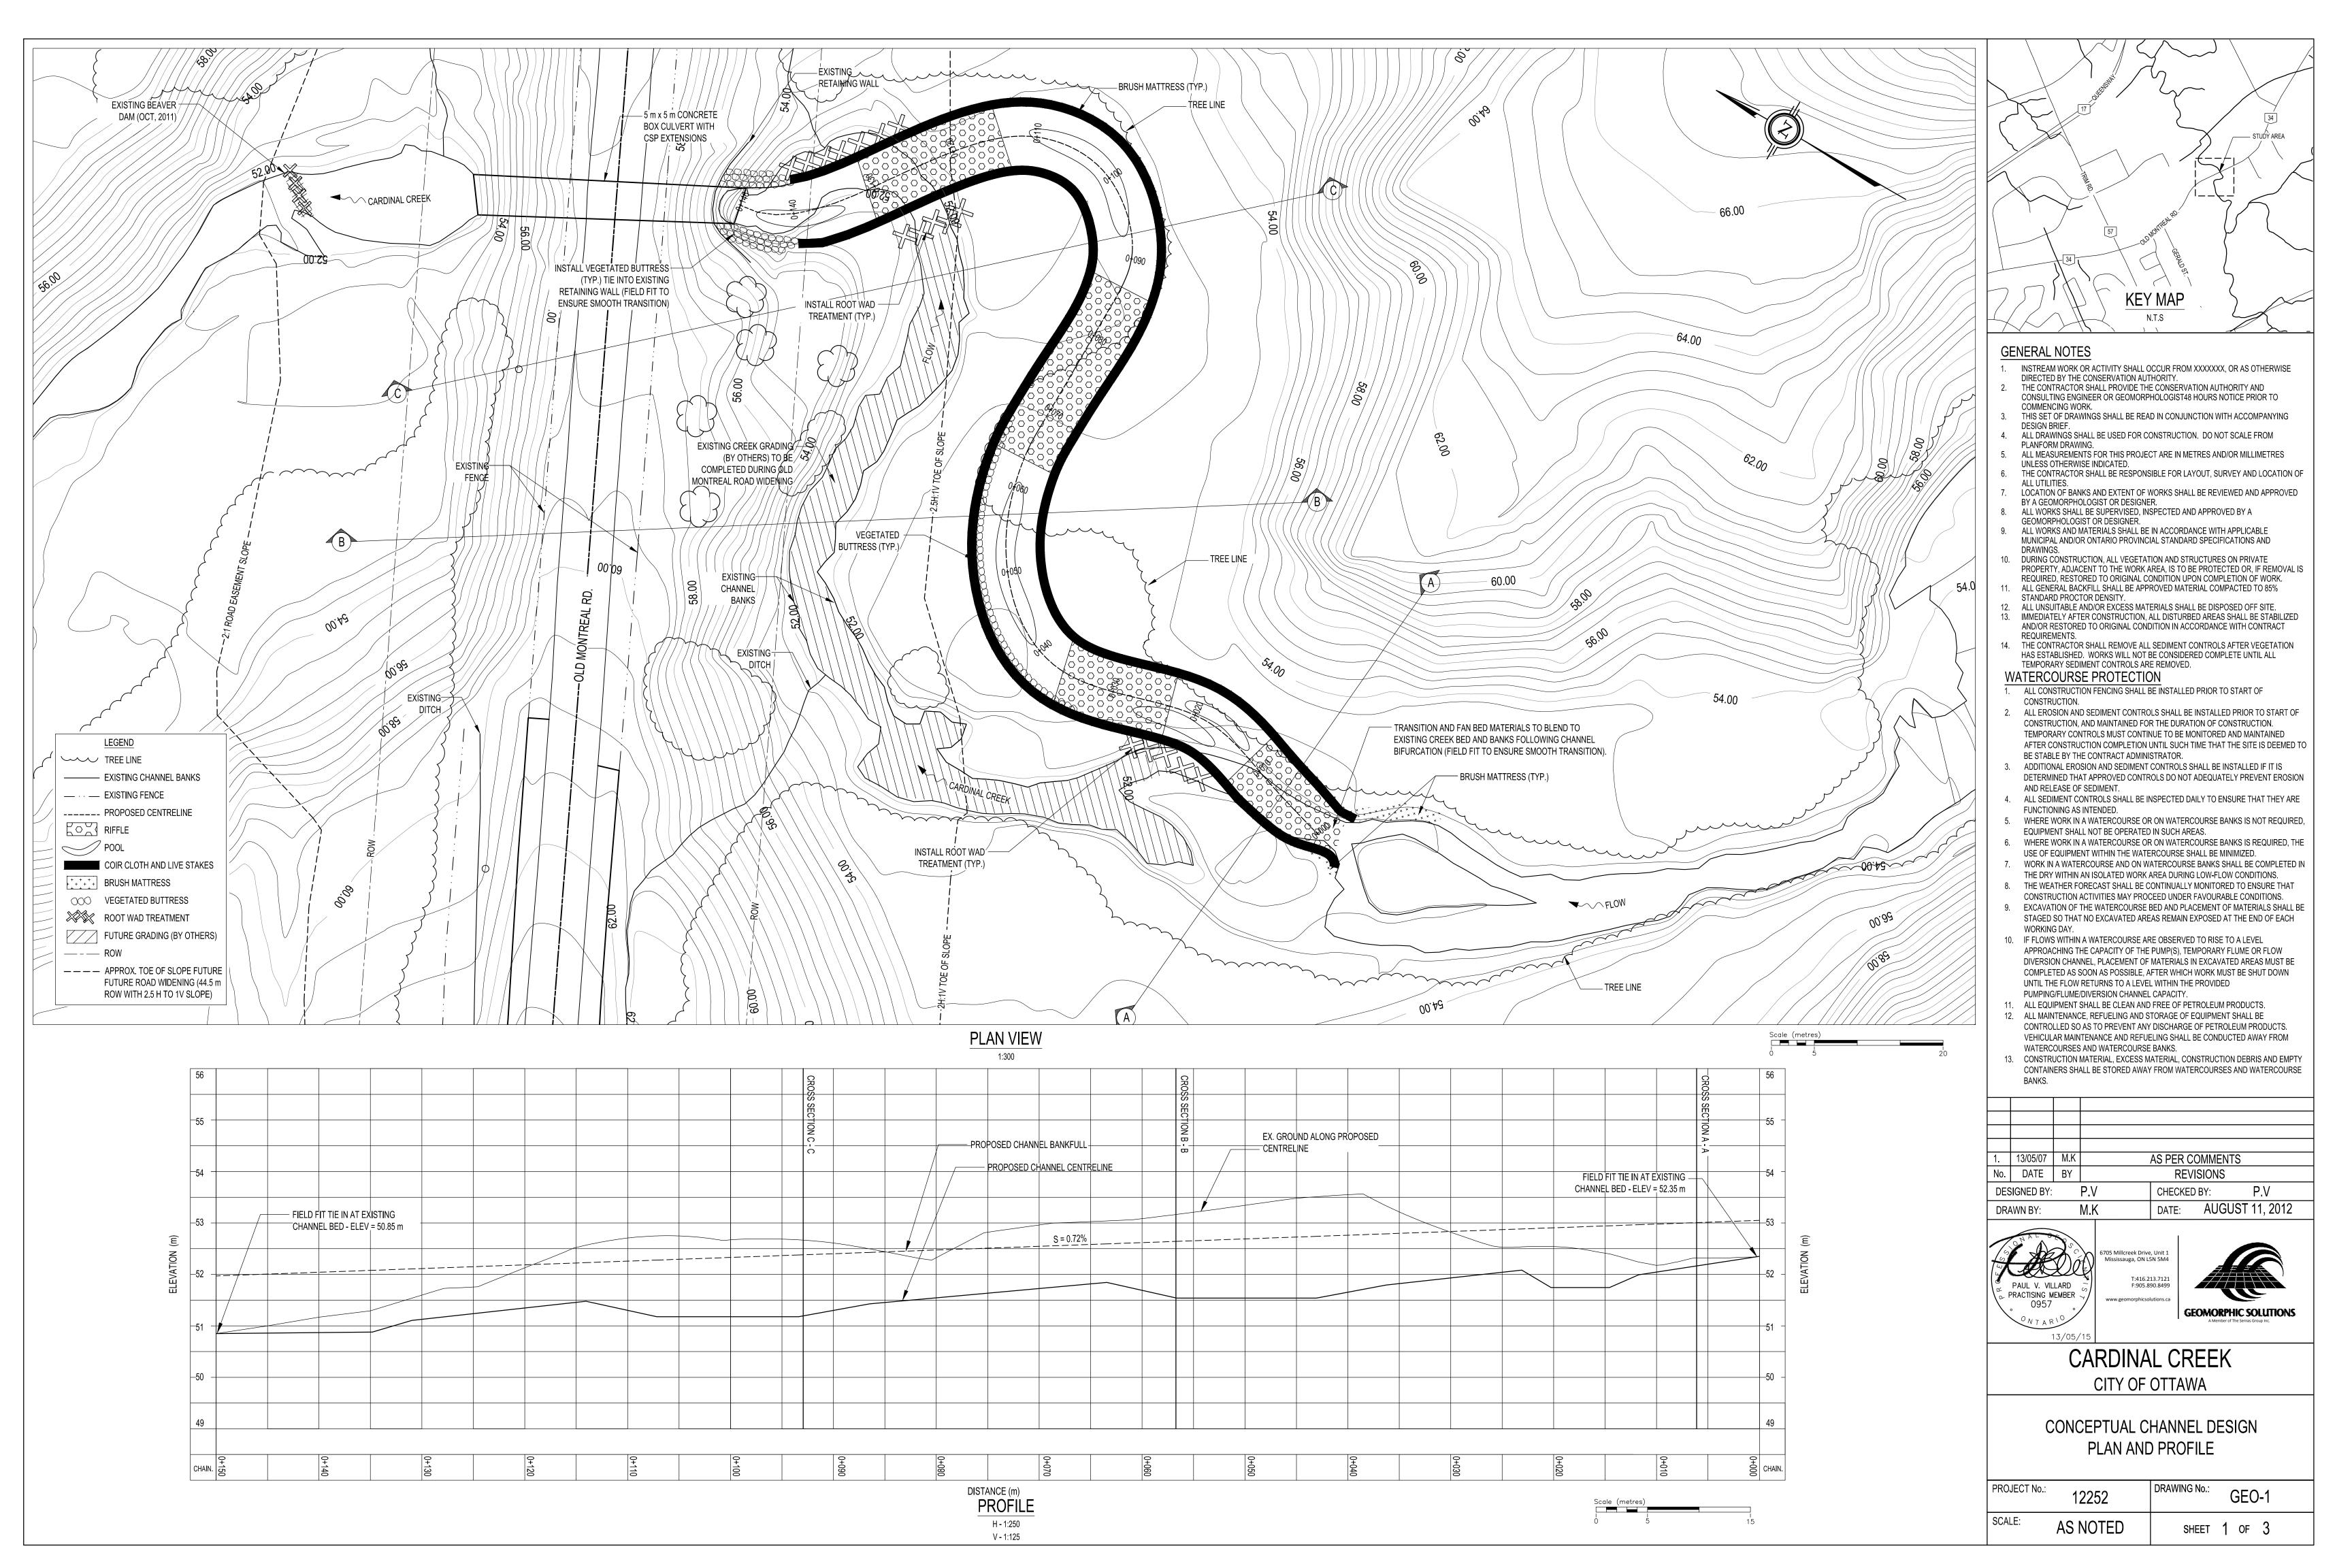

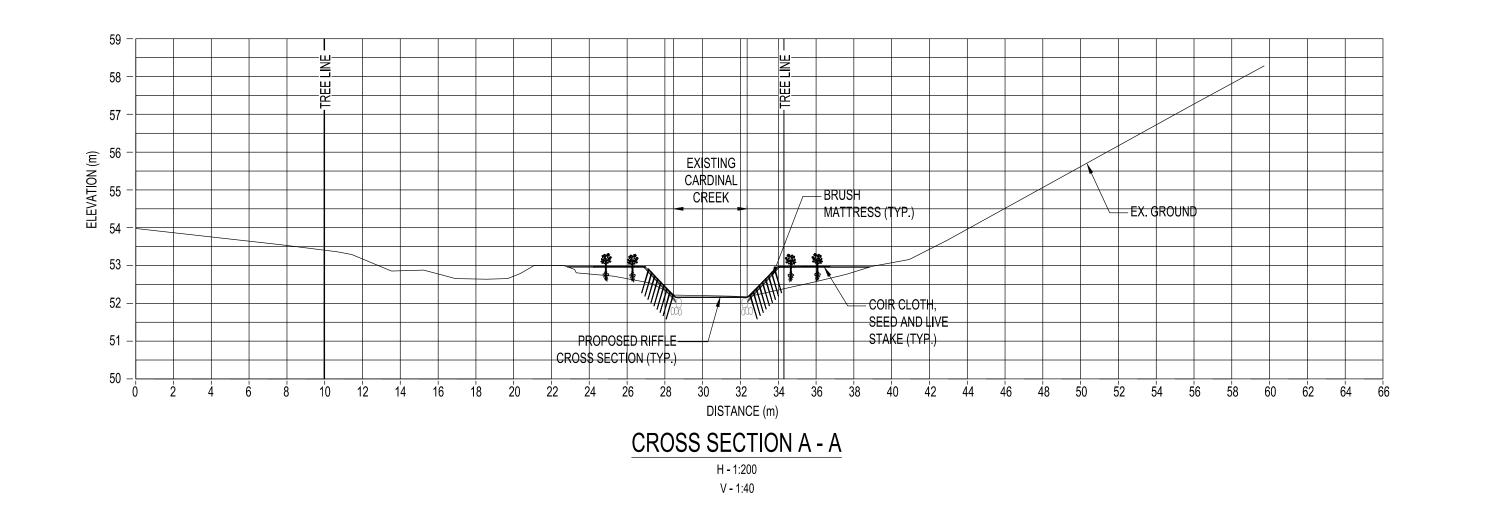

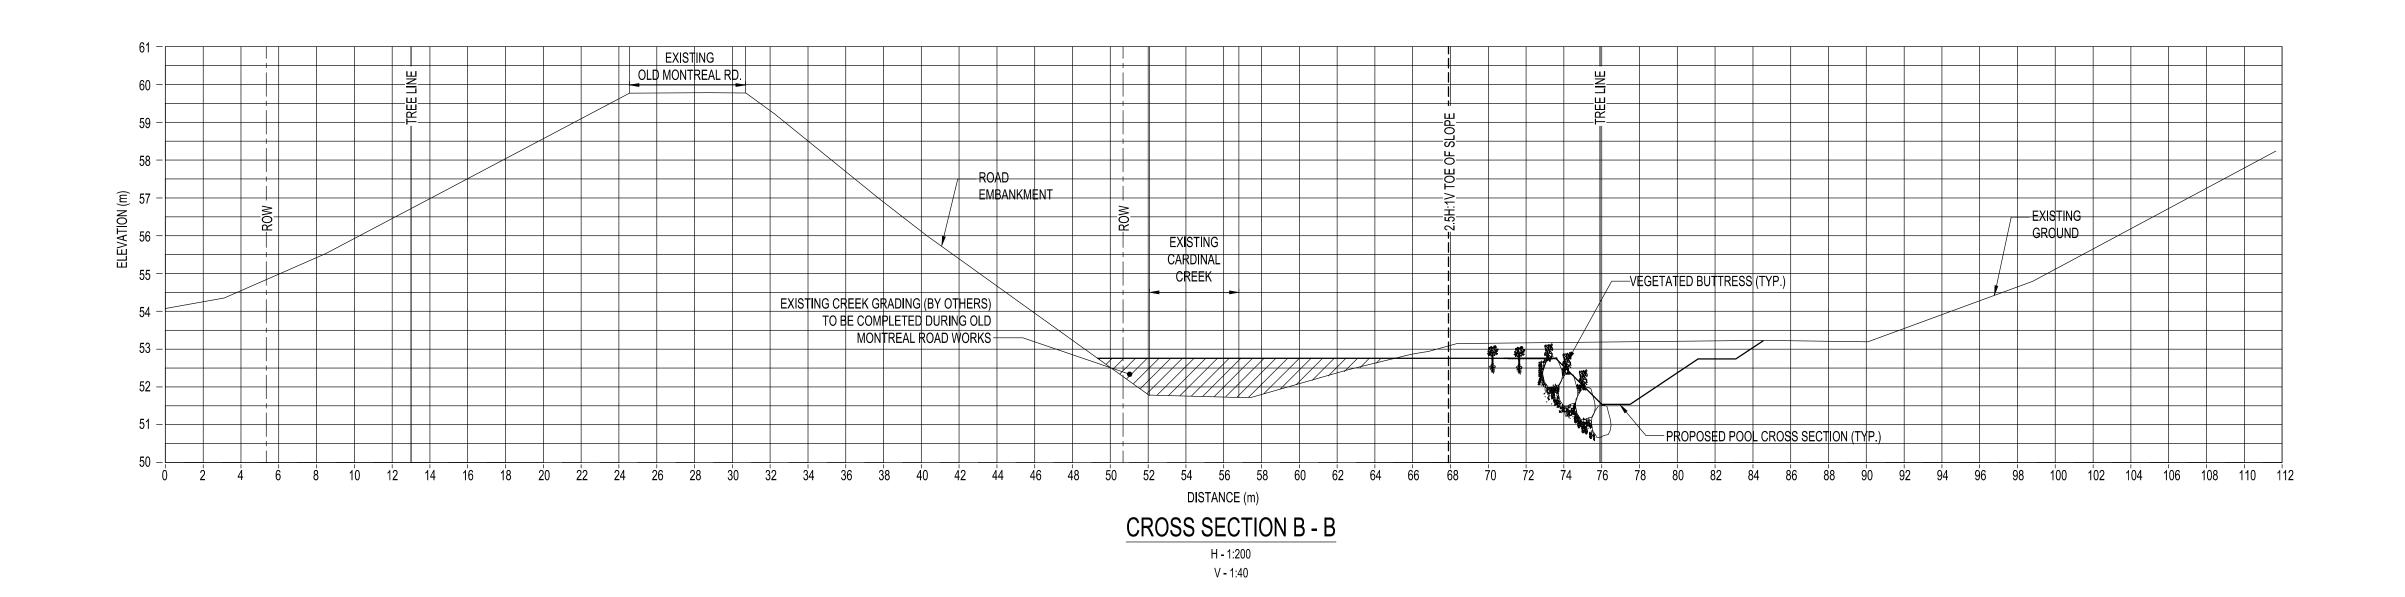

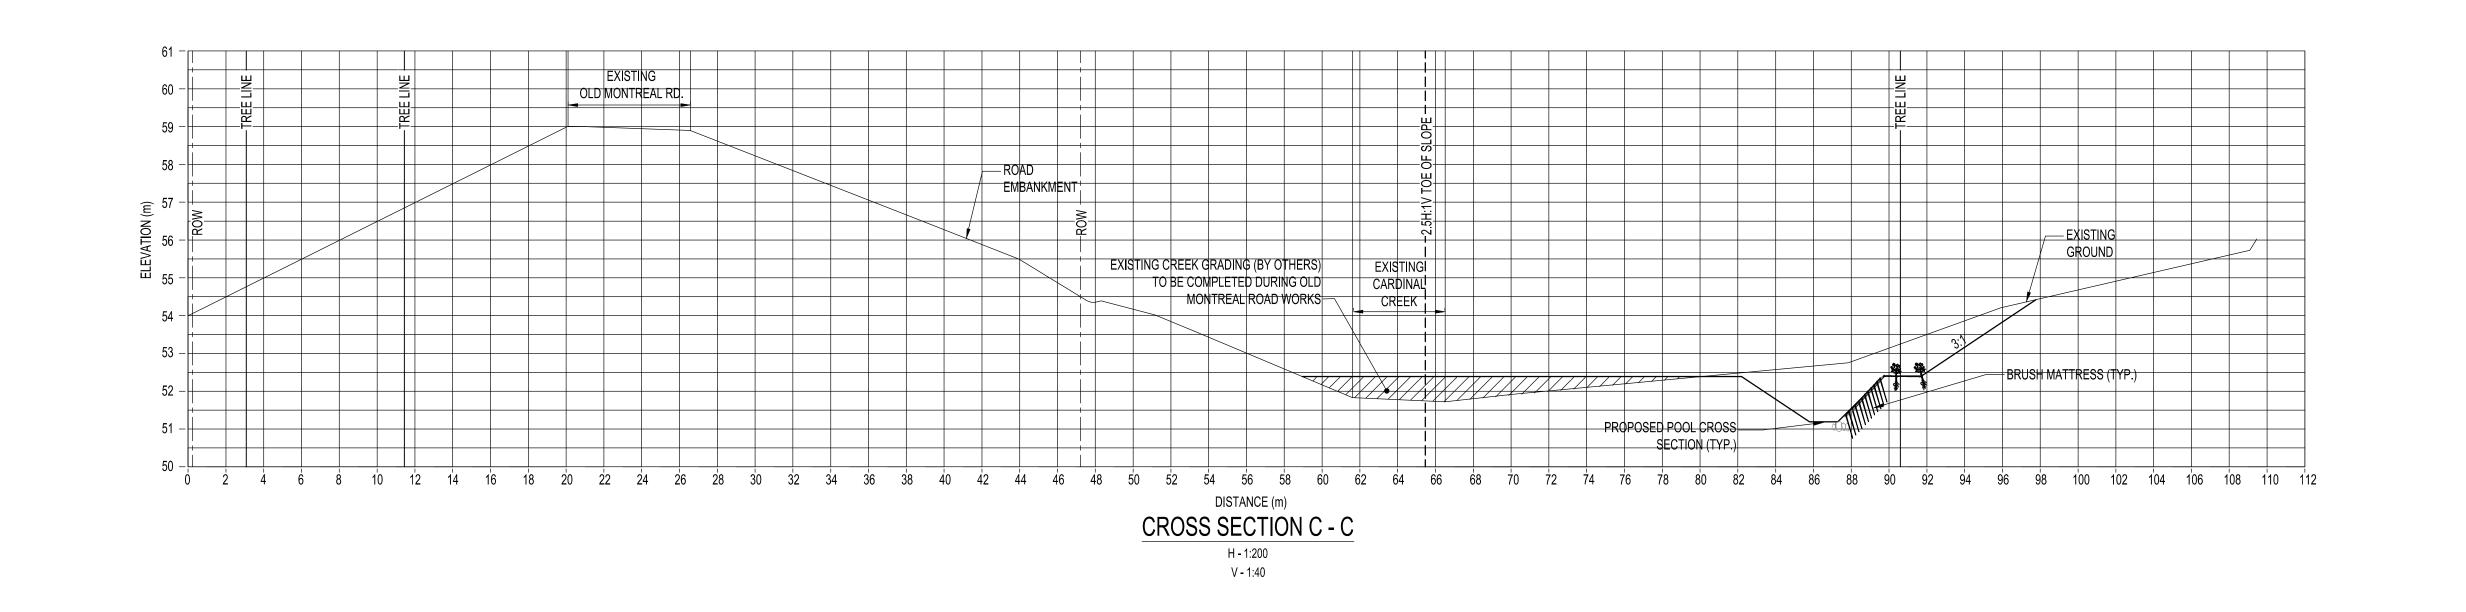

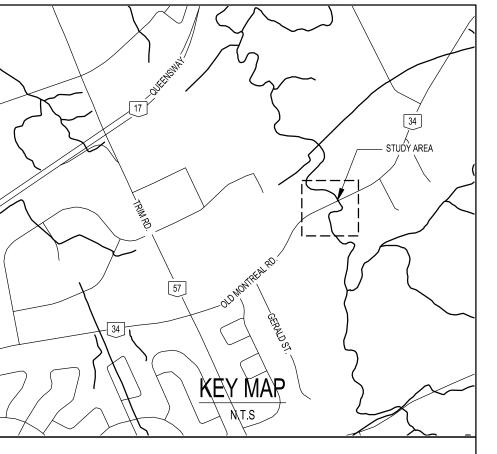


GENERAL NOTES

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- PLANFORM DRAWING.
- ALL MEASUREMENTS FOR THIS PROJECT ARE IN METRES AND/OR MILLIMETRES UNLESS OTHERWISE INDICATED. 6. THE CONTRACTOR SHALL BE RESPONSIBLE FOR LAYOUT, SURVEY AND LOCATION OF
- ALL UTILITIES. LOCATION OF BANKS AND EXTENT OF WORKS SHALL BE REVIEWED AND APPROVED
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- 10. DURING CONSTRUCTION, ALL VEGETATION AND STRUCTURES ON PRIVATE PROPERTY, ADJACENT TO THE WORK AREA, IS TO BE PROTECTED OR, IF REMOVAL IS
- REQUIRED, RESTORED TO ORIGINAL CONDITION UPON COMPLETION OF WORK. 11. ALL GENERAL BACKFILL SHALL BE APPROVED MATERIAL COMPACTED TO 85% STANDARD PROCTOR DENSITY.
- 12. ALL UNSUITABLE AND/OR EXCESS MATERIALS SHALL BE DISPOSED OFF SITE. 13. IMMEDIATELY AFTER CONSTRUCTION, ALL DISTURBED AREAS SHALL BE STABILIZED
- AND/OR RESTORED TO ORIGINAL CONDITION IN ACCORDANCE WITH CONTRACT REQUIREMENTS. 14. THE CONTRACTOR SHALL REMOVE ALL SEDIMENT CONTROLS AFTER VEGETATION
- HAS ESTABLISHED. WORKS WILL NOT BE CONSIDERED COMPLETE UNTIL ALL TEMPORARY SEDIMENT CONTROLS ARE REMOVED. WATERCOURSE PROTECTION

1. ALL CONSTRUCTION FENCING SHALL BE INSTALLED PRIOR TO START OF

- CONSTRUCTION.
- 2. ALL EROSION AND SEDIMENT CONTROLS SHALL BE INSTALLED PRIOR TO START OF CONSTRUCTION, AND MAINTAINED FOR THE DURATION OF CONSTRUCTION. TEMPORARY CONTROLS MUST CONTINUE TO BE MONITORED AND MAINTAINED AFTER CONSTRUCTION COMPLETION UNTIL SUCH TIME THAT THE SITE IS DEEMED TO BE STABLE BY THE CONTRACT ADMINISTRATOR.
- ADDITIONAL EROSION AND SEDIMENT CONTROLS SHALL BE INSTALLED IF IT IS DETERMINED THAT APPROVED CONTROLS DO NOT ADEQUATELY PREVENT EROSION AND RELEASE OF SEDIMENT.
- 4. ALL SEDIMENT CONTROLS SHALL BE INSPECTED DAILY TO ENSURE THAT THEY ARE FUNCTIONING AS INTENDED.
- 5. WHERE WORK IN A WATERCOURSE OR ON WATERCOURSE BANKS IS NOT REQUIRED, EQUIPMENT SHALL NOT BE OPERATED IN SUCH AREAS. 6. WHERE WORK IN A WATERCOURSE OR ON WATERCOURSE BANKS IS REQUIRED, THE
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- THE DRY WITHIN AN ISOLATED WORK AREA DURING LOW-FLOW CONDITIONS.
- 8. THE WEATHER FORECAST SHALL BE CONTINUALLY MONITORED TO ENSURE THAT CONSTRUCTION ACTIVITIES MAY PROCEED UNDER FAVOURABLE CONDITIONS. 9. EXCAVATION OF THE WATERCOURSE BED AND PLACEMENT OF MATERIALS SHALL BE
- STAGED SO THAT NO EXCAVATED AREAS REMAIN EXPOSED AT THE END OF EACH WORKING DAY. 10. IF FLOWS WITHIN A WATERCOURSE ARE OBSERVED TO RISE TO A LEVEL
- APPROACHING THE CAPACITY OF THE PUMP(S), TEMPORARY FLUME OR FLOW DIVERSION CHANNEL, PLACEMENT OF MATERIALS IN EXCAVATED AREAS MUST BE COMPLETED AS SOON AS POSSIBLE, AFTER WHICH WORK MUST BE SHUT DOWN UNTIL THE FLOW RETURNS TO A LEVEL WITHIN THE PROVIDED PUMPING/FLUME/DIVERSION CHANNEL CAPACITY. 11. ALL EQUIPMENT SHALL BE CLEAN AND FREE OF PETROLEUM PRODUCTS.
- 12. ALL MAINTENANCE, REFUELING AND STORAGE OF EQUIPMENT SHALL BE CONTROLLED SO AS TO PREVENT ANY DISCHARGE OF PETROLEUM PRODUCTS. VEHICULAR MAINTENANCE AND REFUELING SHALL BE CONDUCTED AWAY FROM WATERCOURSES AND WATERCOURSE BANKS.
- 13. CONSTRUCTION MATERIAL, EXCESS MATERIAL, CONSTRUCTION DEBRIS AND EMPTY CONTAINERS SHALL BE STORED AWAY FROM WATERCOURSES AND WATERCOURSE

1.	13/05/07	M.K	7.01 ER OOMMENTO			
No.	DATE	BY				
DESIGNED BY:			P.V	CHECKED	BY:	P.V
DRAWN BY:			M.K	DATE:	AUGUST	11, 2012

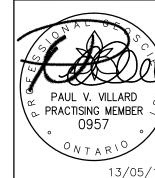

6705 Millcreek Drive, Unit 1 Mississauga, ON L5N 5M4 T:416.213.712








CARDINAL CREEK CITY OF OTTAWA


CONCEPTUAL CHANNEL DESIGN **CROSS SECTIONS**


PROJECT No.: DRAWING No.: GEO-2 SCALE: AS NOTED SHEET 2 OF 3

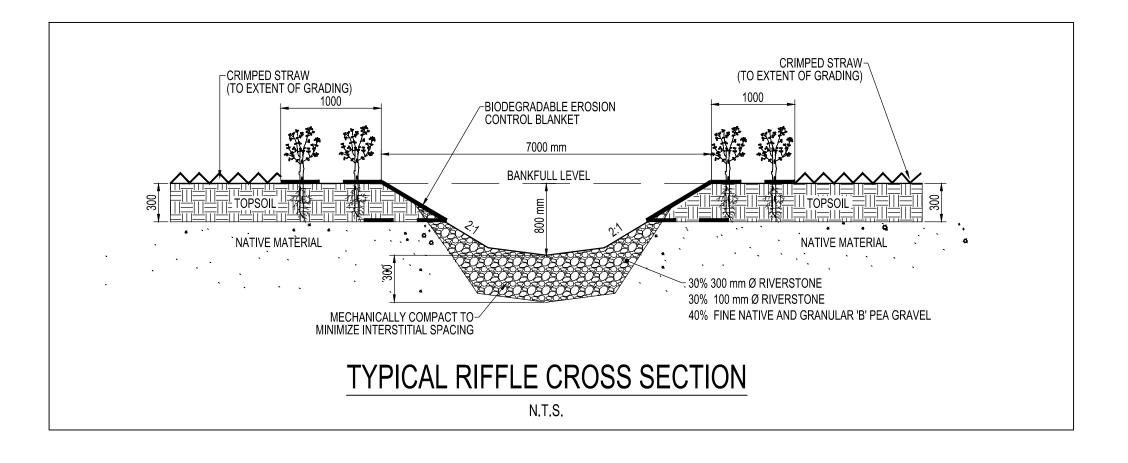

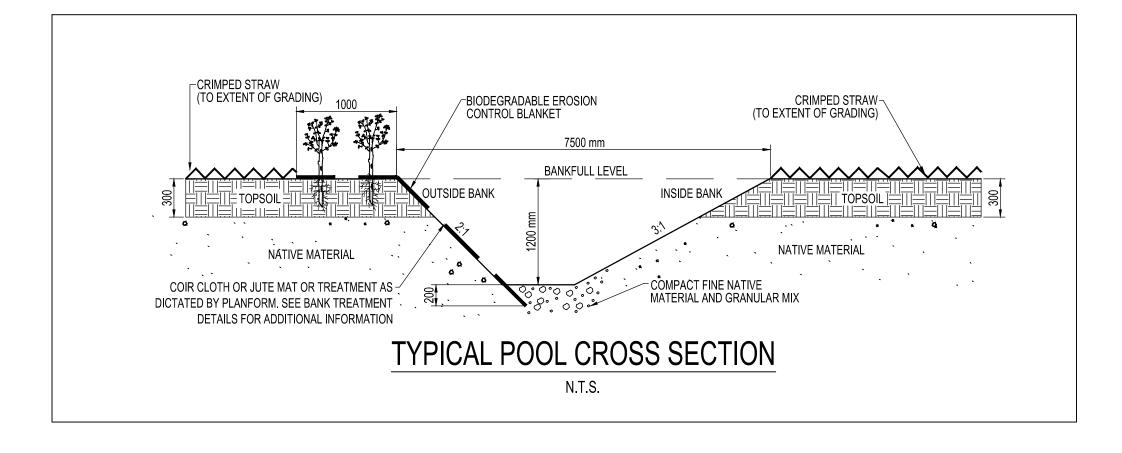

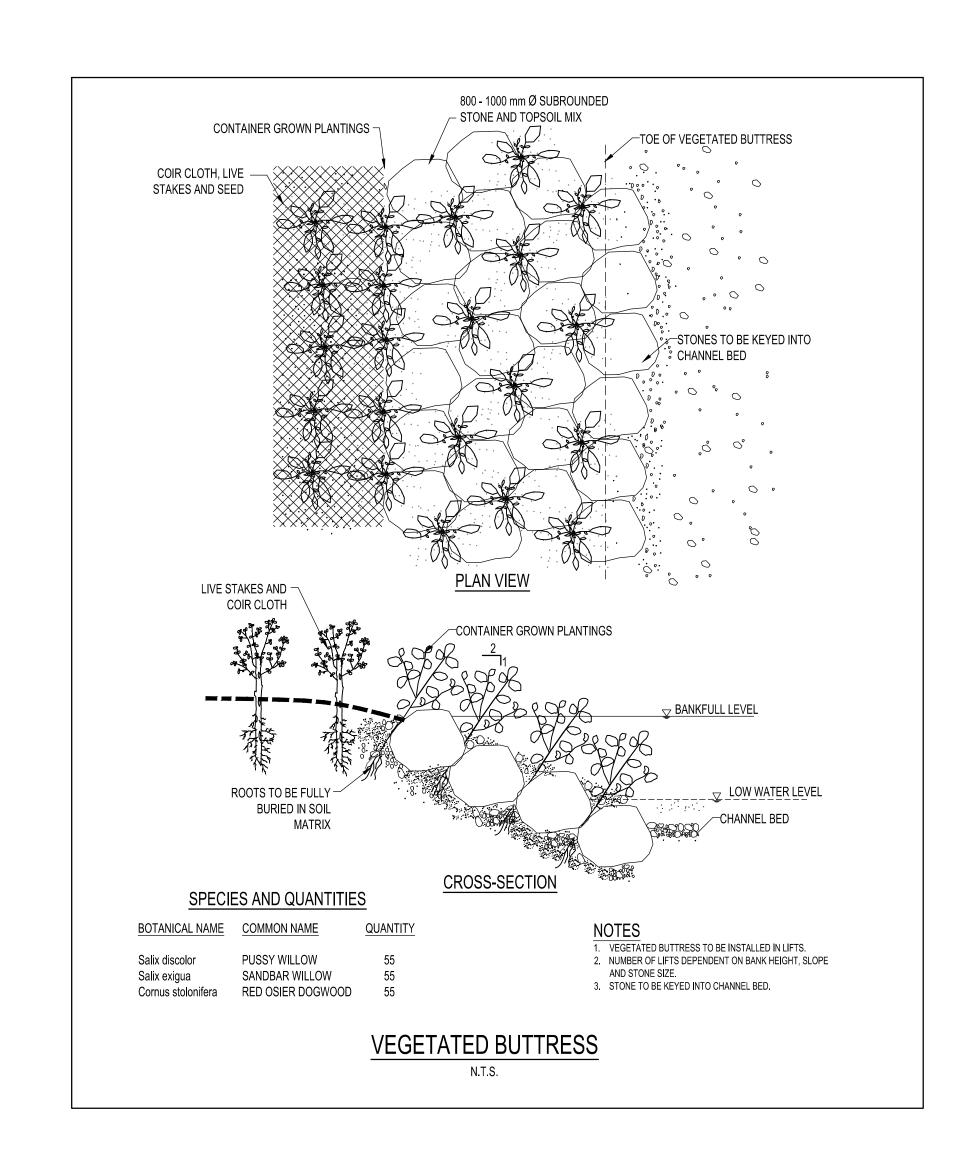


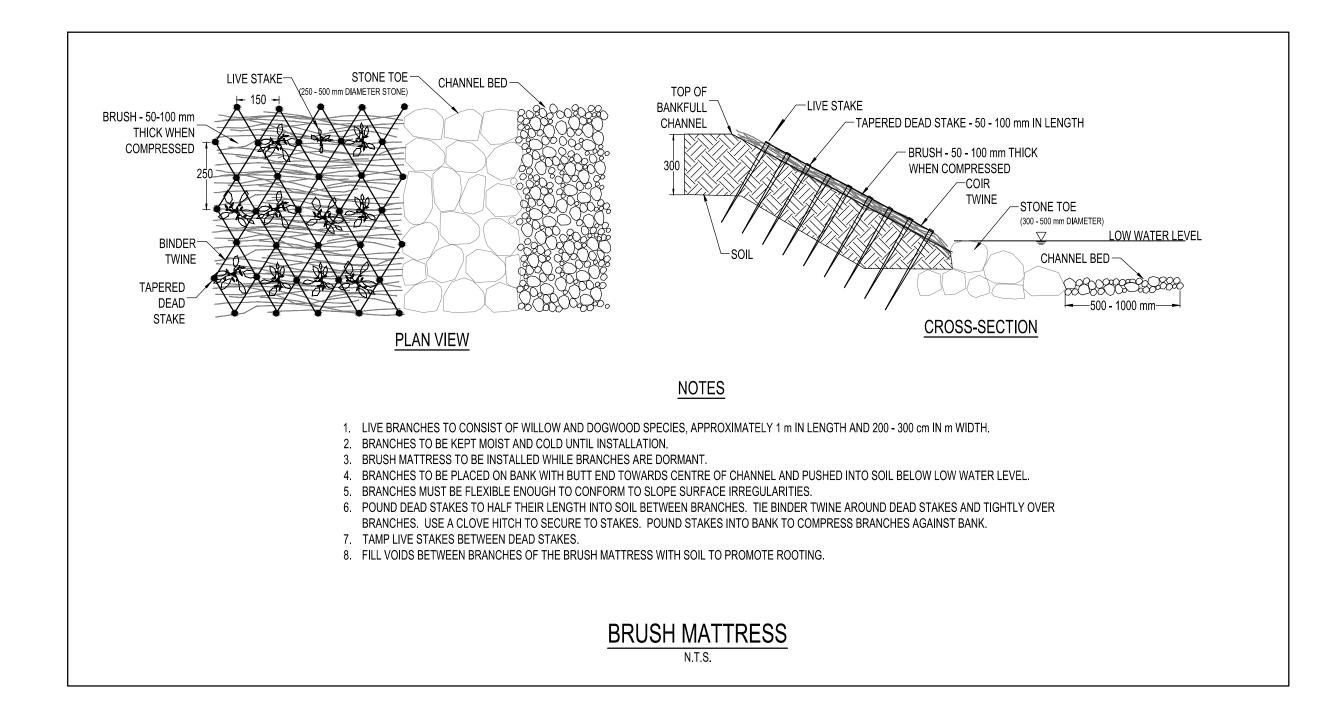


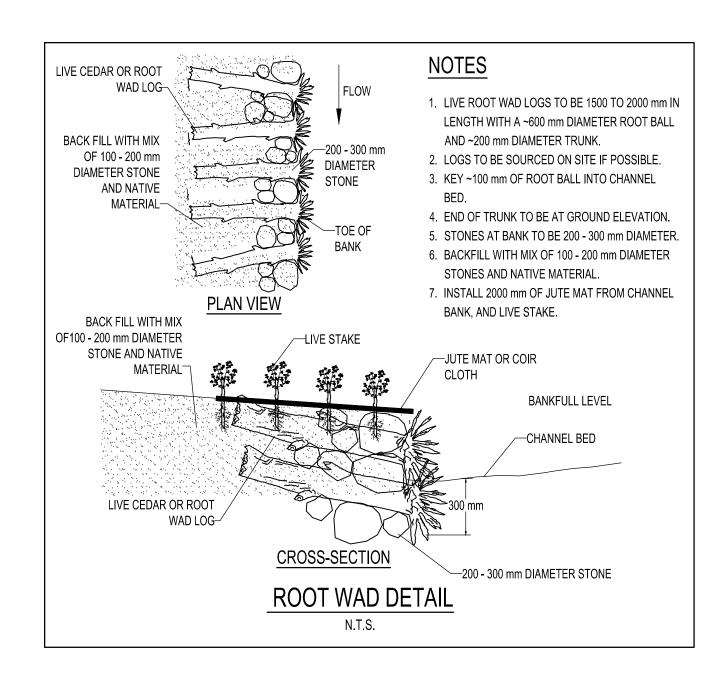

RIPARIAN SEED MIX

- APPLY PICKSEED "NATURE PRO" (WET NATIVE GRASS MIXTURE) SEED MIX AT A RATE OF 20.0 KG/HA. SPECIES INCLUDED AND APPROXIMATE VOLUME OF THE TOTAL BY WEIGHT:
- 20% PRAIRIE CORDGRASS (Spartina pectinata)
 20% CANADA BLUEJOINT (Calamagrostis canadensis)
 20% SWITCHGRASS (Panicum virgatum)
- 20% SWITCHGRASS (*Panicum virgatum*) 20% RIVERBANK RYE (*Elymus riparius*) 20% FOWL MANNAGRASS (*Glyceria striata*)
- 2. SIMULTANEOUSLY SOW COVER CROP OF ANNUAL OATS FOR EROSION CONTROL AT A RATE OF 30 KG/HA.

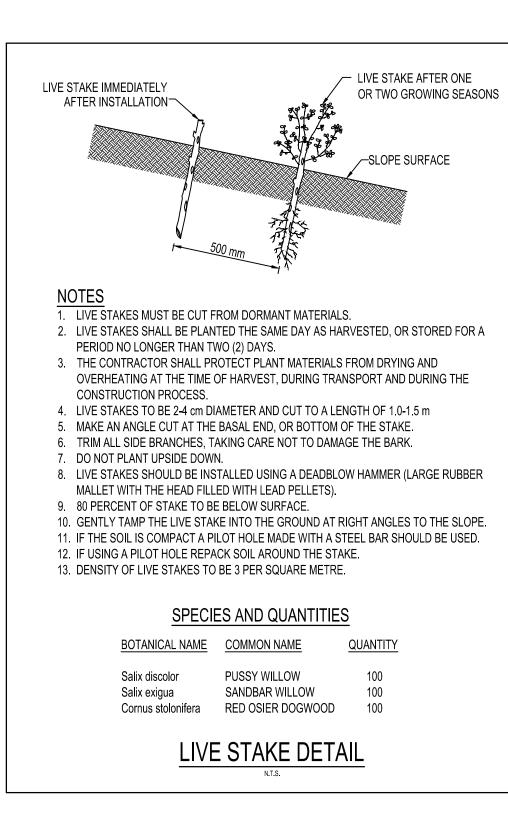

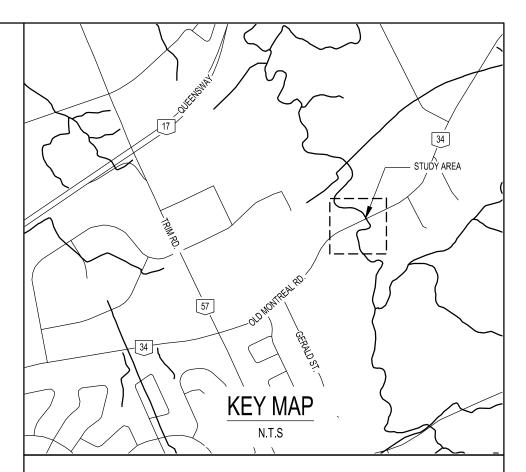

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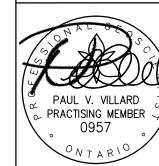
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1.	13/05/07	M.K	AS PER COMMENTS				
No.	DATE	BY	REVISIONS				
DESIGNED BY:			P.V	CHECKED	BY:	P.V	
DRAWN BY:			M.K	DATE:	AUGUST	11, 2012	



6705 Millcreek Drive, Unit 1 Mississauga, ON L5N 5M4 T:416.213.712: F:905.890.8499 www.geomorphicsolutions.co



CARDINAL CREEK
CITY OF OTTAWA

CONCEPTUAL CHANNEL DESIGN PLAN AND PROFILE

PROJECT No.: 12252 DRAWING No.: DET-1

SCALE: AS NOTED SHEET 3 OF 3



Whitby: 110 Scotia Court, Unit 41 Whitby, Ontario L1N 8Y7 Mississauga: 6705 Millcreek Drive, Unit 1 Mississauga, Ontario L5N 5M4 Richmond Hill: 45 Vogell Road, Suite 306 Richmond Hill, Ontario L4B 3P6